BLDG PLAN + LIFE SAFETY PLAN

1/8" = 1'-0"

PROJECT LOCATION



LOCATION MAP



FIRE RESCUE STATION 95 LOUNGE RENOVATION

CITY OF GREENACRES

5095 HAVERHILL ROAD GREENACRES, FLORIDA 33463

PROJECT SCOPE + CODE RESEARCH

THE PROJECT SCOPE INVOLVES A LEVEL 2 INTERIOR ALTERATION TO CONVERT THE EXISTING OPEN BUNK ROOM—APPROXIMATELY 480 SQUARE FEET—INTO SIX PRIVATE LOUNGE ROOMS DESIGNED AS RESIDENTIAL R-2 LIVE/WORK UNITS. THIS IS A TURNKEY PROJECT, MEANING THE AWARDED CONTRACTOR WILL PROVIDE/INSTALL FOR TURNKEY DELIVERY, INCLUDING ALL

- DEMOLITION AND INSTALLATION OF VCT FLOORING, BASE, AND ACT CEILING.
- · CONSTRUCTION OF PARTITION WALLS WITH POCKET DOORS FOR EACH LOUNGE. ADDITION OF NEW ELECTRICAL OUTLETS, DATA, AND CABLE CONNECTIONS.
- · INTEGRATION OF HVAC SUPPLY DIFFUSERS, WITH UNDERCUT DOORS FACILITATING RETURN

THE BUILDING IS FULLY SPRINKLER, AND IS EQUIPPED WITH FULL LIFE SAFETY DEVICES THAT CLEARLY IDENTIFY ALL EXIT SIGNS, EXIT ROUTES, LOCATIONS OF ALL FIRE ALARM SYSTEMS, FIRE EXTINGUISHERS AND BATTERY BACKUP LIGHT FIXTURES. ALL MEANS OF EGRESS EQUIPMENT ARE TO REMAIN OPERATIONAL AND CLEARLY VISIBLE THROUGH THE ENTIRE DURATION OF CONSTRUCTION AND AFTER PROJECT COMPLETION.

ALL EXISTING PLUMBING FIXTURES / RESTROOMS ARE EXISTING TO REMAIN. THE ALTERATION DOES NOT INCREASE THE REQUIRED NUMBER OF PLUMBING FIXTURES FOR THE TENANT SPACE.

NO NEW PLUMBING FIXTURES ARE REQUIRED.

GENERAL ELECTRICAL NOTES ALL EXISTING LIGHT FIXTURES, BATTERY BACKUP FIXTURES AND RELATED CONTROLS WITHIN THE AREA OF WORK ONLY ARE TO BE REPLACE IN KIND.

NO OTHER ELECTRICAL WORK IS TO BE PREFORMED OUTSIDE THE AREA OF WORK.

GENERAL MECHANICAL NOTES

ALL EXISTING MECHANICAL DUCTS WITHIN THE AREA OF WORK ARE TO BE RE-DIRECTED PER MECHANICAL PLAN.

NO OTHER MECHANICAL WORK IS TO BE PREFORMED OUTSIDE THE AREA OF WORK.

INTERIOR FINISHES

INTERIOR FINISHES FOR R-2 LIVE/WORK UNITS

EXIT ENCLOSURES SHALL HAVE MINIMUM CLASS 'B' CORRIDORS SHALL HAVE MINIMUM CLASS 'B' ALL REMAINING SPACES SHALL HAVE MINIMUM CLASS 'B'

ALL INTERIOR WALL AND CEILING FINISHES SHALL BE CLASSIFIED IN ACCORDANCE WITH: CLASS A: FLAME SPREAD 0-25; SMOKE DEVELOPED 0-450

CLASS B: FLAME SPREAD 26-75; SMOKE DEVELOPED 0-450 CLASS C: FLAME SPREAD 76-200; SMOKE DEVELOPED 0-450

ASTM E 84. MATERIALS OTHER THAN TEXTILES SHALL BE TESTED IN ACCORDANCE WITH NFPA

ARCHITECT

ROBLING ARCHITECTURE CONSTRUCTION, INC.

101 WALKER AVE. GREENACRES, FL 33463 T: 561-649-6705

MEP ENGINEER

BEACON CONSULTING ENGINEERS, LLC. 625 CASA LOMA BLVD, SUITE 106 BOYNTON BEACH, FL 33435 T: 561-424-3270

THE ARCHITECTURAL DRAWING INDEX TAKES PRECEDENCE OVER ANY CONSULTANT INDEXES THAT MAY BE SHOWN ON CONSULTANT'S DRAWINGS. ANY INCORRECT DRAWING INDEX SHOWN ON CONSULTANT'S DRAWINGS SHALL BE DISREGARDED.

SHEET INDEX

SHEET		ISSUE	DRAWING HISTORY		
NO	SHEET NAME	DATE	REV NO	REV DATE	
GENERAL	_				
T1.0	COVER SHEET	06/11/25			
T1.1	NOTES, ABBREVIATIONS & LEGEND	06/11/25			
ARCHITE				T	
A1.1	FLOOR PLANS	06/11/25	1	10/29/25	
A2.1	REFLECTED CEILING PLANS	06/11/25			
A6.1	MISCELLANEOUS DETAILS	06/11/25			
A8.1	DOOR AND WINDOW SCHEDULE & ELEVATIONS	06/11/25	1	10/29/25	
MECHAN:	ICAL				
M0.1	MECHANICAL NOTES, LEGEND, & SHEET INDEX	06/11/25			
M1.1	MECHANICAL PLAN	06/11/25			
M2.1	MECHANICAL DETAILS	06/11/25			
ELECTRI	_			1	
E0.1	ELECTRICAL NOTES, LEGEND, & SHEET INDEX	06/11/25			
E1.1	POWER PLAN	06/11/25			
	LIGHTING PLAN	06/11/25			
E2.1	LIGHTING I LAN	00/11/20			

06/11/25

FP0.1 FIRE PROTECTION NOTES, LEGEND, & SHEET INDEX

FP1.1 FIRE PROTECTION PLAN



5800 MELALEUCA LANE GREENACRES, FL, 33463

ARCHITECTURE CONSTRUCTION

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AA26001115 EB28211 CGC1504260

WWW.ROBLING.COM

CONSULTANT

PROJECT TITLE

FIRE RESCUE STATION 95 LOUNGE RENOVATION

PROJECT ADDRESS 5095 HAVERHILL RD,

SUBMITTAL HISTORY

GREENACRES, FL 33463

No. DATE DESCRIPTION

THE DRAWINGS AND SPECIFICATIONS INCLUDED OR REFERENCED HEREIN SHALL BE USED AS A COMPLETE SET AND SHALL NOT BE SEPARATED INTO

DISCIPLINE.

INFORMATION CONTAINED ON ONE SHEET MAY SPECIFICALLY APPLY TO INFORMATION OR CONDITIONS ILLUSTRATED ON OTHER SHEETS.

INDIVIDUAL SHEETS OR BY

IT IS THE CONTRACTORS RESPONSIBILITY TO VERIFY THAT SUCH ITEMS ARE COORDINATED AND INCLUDED IN ANY PRICING INFORMATION. FIELD VERIFY AND NOTIFY THE ARCHITECT OF ANY DEVIATIONS FROM THE PLANS AND / OR SPECS

PRIOR TO CONSTRUCTION

© ROBLING ARCHITECTURE CONSTRUCTION, INC.



DIGITAL SEAL

PROJECT NUMBER 585-2024-01

SHEET TITLE

COVER SHEET

IATIONS

ARCHI	TECTURAL ABBI	REVI
ABV	ABOVE	JB
A/C	AIR CONDITIONING	JT
ACC	ACCESIBLE	MANF
ACT	ACOUSTICAL CEILING TILE	MAT
AD	AREA DRAIN	MAX
ADJ	ADJUSTIBLE	MECH
AFF	ABOVE FINISH FLOOR	MEP
AHU	AIR HANDLER UNIT	
ALUM	ALUMINUM	MIN
APPROX	APPROXIMATE	MISC
BD	BOARD	MO
BLDG	BUILDING	MTD
		MTL
BLK	BLOCK	
BM	BEAM BOTTOM OF BEAM	NIC
BOB	BOTTOM OF BEAM	NOA
BUR	BUILT-UP ROOF	NTS
CAB	CABINET	OH
CIP	CAST IN PLACE	OC
CJ	CONTROL JOINT	OD
CL	CENTERLINE	OLF
CLF	CHAIN LINK FENCE	OPP
CLO	CLOSET	OTH
CLR	CLEAR	PJ
CLG	CEILING	PLAM
CMU	CONCRETE MASONRY UNIT	PLYWD
COL	COLUMN	POB
COORD	COORDINATE	PREFAB
CONT	CONTINUOUS	PSF
CORR	CORRIDOR	PSI
CUST	CUSTODIAL	PT
D	DEPTH	R.
DDC	DISTRICT DESIGN CRITERIA	RA
DF	DRINK FOUNTAIN	RAD / R
DMS	DISTRICT MASTER SPECIFICATIONS	RD RD
DN	DOWN	REF
DWG	DRAWING	REINF
EA	EACH	REQ'D
EC	EASED CORNER	REC
EF EF	EXHAUST FAN	
		RM
E)	EXPANSION JOINT	RO
ELECT	ELECTRICAL FLATOR	RWL
ELEV	ELEVATION / ELEVATOR	SC
EQ	EQUAL	SCHED
EQUIP	EQUIPMENT	SHT
EXIST	EXISITING	SHWR
EXP	EXPANSION	SIM
EWC	ELECTRIC WATER COOLER	SP
EXT	EXTERIOR	SPEC(S)
FD	FLOOR DRAIN	SS
FE	FIRE EXTINGUISHER	STD
FEC	FIRE EXTINGUISHER COOLER	STO
FDN	FOUNDATION	STL
FG	FIRE RATED GLAZING	STU
FHC	FIRE HOSE CABINET	SUSP
FIN	FINISH	T
EE	FINISH FLOOD	TRD

FINISH FLOOR

FEET / FOOT

GALVANIZED

FIRE RETARDANT

FIRE RETARDANY TREATED

GLASS UNITY MASONRY

GYPSUM WALL BOARD

HOLLOW CORE WOOD

IMPACT RATED GLAZING

HOLLOW METAL

INSULATION

INTERIOR

INSIDE DIAMETER

FLOOR

GAUGE

GENERAL

GYPSUM

HEIGHT

GLASS

GEN

SYMBOL LEGEND

ROOM NAME

GROSS AREA SF

01/T1.1

01/T1.1 ◀

 $\langle \mathsf{FE} \rangle$

LIFE SAFETY PATH OF TRAVEL

NOT INCLUDED IN PROJECT AREA

EXISTING TO REMAIN

LINE TYPE LEGEND

TO BE DEMOLISHED/REMOVED

HATCH LEGEND

ROOM # **→** ROOM TAG

WINDOW TAG

KEY NOTE

— ACCESSORY TAG

EXTERIOR ELEVATION TAG

INTERIOR ELEVATION TAG

BUILDING SECTION TAG

DIRECTION OF VIEW

DETAIL & SHEET #

WALL SECTION TAG

DIRECTION OF VIEW

DETAIL & SHEET #

DETAIL SECTION

— DETAIL & SHEET #

DIRECTION OF VIEW

REVISION CLOUD

—— DETAIL #

- DETAIL WINDOW

ENLARGEMENT

FIRE EXTINGUISHER - MP5 (OR

SHEET #

ADA ACCESSIBLE

APPROVED EQUAL)

AND TAG

01/T1.1

DIRECTION OF VIEW

— DETAIL & SHEET #

01/T1.1 ◀ DETAIL & SHEET #

ΓIONS	S
JOIST BEARING JOINT	
MANUFACTURER	
MATERIAL	
MAXIMUM MECHANICAL	
MECHANICAL /	
ELECTRICAL / PLUMBING	
MINIMUM MISCELLANEOUS	
MASONRY OPENING	
MOUNTED METAL	
NOT IN CONTRACT	
NOTICE OF ACCEPTANCE	
NOT TO SCALE OVERHEAD	
ON CENTER	
OUTSIDE DIAMETER	
OCCUPANT LOAD FACTOR OPPOSITE	
OTHER	
PANEL JOINT PLASTIC LAMINATE	
PLYWOOD	
POINT OF BEGINNING	
PREFABRICATED POUNDS PER SQUARE FOOT	
POUNDS PER SQUARE INCH	
PRESSURE TREATED RISE	
RETURN AIR	
RADIUS	
ROOF DRAIN REFRIGERATOR	
REINFORCING	
REQUIRED REVERSE	
ROOM	
ROUGH OPENING	
RAIN WATER LEADER SOLID CORE WOOD	
SCHEDULE	
SHEET SHOWER	
SIMILAR	
SPACE SPECIFICATION(S)	
STAINLESS STEEL	
STANDARD STORAGE	
STEEL	
STUDENT	
SUSPENDED THICKNESS / TREAD	
TO BE DETERMINED	
TEMPERED SAFETY GLAZING TOP OF BEAM	
TOP OF CONCRETE	
TOP OF FOOTING TOP OF INSULATION	
TOP OF MASONRY	
TOP OF PARAPET	
TOP OF SLAB TOP OF WALL	
TYPICAL	
UNLESS NOTED OTHERWISE VERTICAL	
VESTIBULE	
VERIFY IN FEILD	
VINYL COMPOSITION TILE WIDE / WIDTH	

WITH

WOOD

WIDE / WIDTH

WELDED WIRE FABRIC

TO/B

TO/ C

TO/ F

TO/ I

TO/ M

TO/ P

TO/S

VERT


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WD

WWF

TO/ W

RENOVATION GENERAL NOTES

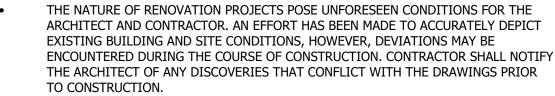

IT IS NOT THE INTENT OF THESE PLANS TO SHOW EVERY MINOR DETAIL OF CONSTRUCTION. THE CONTRACTOR IS EXPECTED TO COORDINATE, FURNISH AND INSTALL ALL ITEMS REQUIRED FOR A COMPLETE AND FUNCTIONAL **INSTALLATION.** THE CONTRACTOR SHALL USE THE PLANS IN CONJUNCTION WITH THE SPECIFICATIONS. ANY DISCREPANCIES SHALL BE BROUGHT TO THE ARCHITECT'S ATTENTION IN WRITING PRIOR TO SUBMITTING THE CONSTRUCTION COSTING INFORMATION AND PRIOR TO CONSTRUCTION. IF A CONFLICT OCCURS WITHIN THE CONTRACT DOCUMENTS, THE CONTRACTOR IS DEEMED TO HAVE BASED THE CONSTRUCTION COSTS ON THE MORE EXPENSIVE MATERIAL AND / OR METHOD OF COMPLETING THE WORK, UNLESS THE CONTRACTOR HAS REQUESTED AND RECEIVED A WRITTEN DECISION FROM THE ARCHITECT PRIOR TO SUBMITTING THE FINAL PRICING.

EXISTING CONDITIONS SHOWN IN THESE DRAWINGS ARE BASED ON FIELD OBSERVATIONS AND RECORD DOCUMENTS FURNISHED BY THE OWNER, THAT MAY NOT SHOW ALL BUILDING / SITE CONDITIONS. CONTRACTOR TO VISIT THE SITE AND FAMILIARIZE ITSELF WITH ALL EXISTING CONDITIONS AFFECTING THE WORK INCLUDING BUT NOT LIMITED TO: PRIVATE AND PUBLIC UTILITIES ON AND OFF THE SITE, ACCESS ROADS AND OTHER SUPPORT FACILITIES BEFORE SUBMITTING COST

INFORMATION, BIDS OR COMMENCING WORK. UNLESS SPECIFICALLY NOTED OTHERWISE HEREIN INSTALL ALL MATERIAL / PRODUCTS FOR THIS PROJECT IN STRICT ACCORDANCE WITH THE MANUFACTURERS LATEST PUBLISHED SPECIFICATIONS / RECOMMENDATIONS. IF CONFLICT ARISES, NOTIFY

ARCHITECT PRIOR TO PROCEEDING. THE CONTRACTOR SHALL COVER AND PROTECT ALL EXISTING TO REMAIN AND NEWLY INSTALLED FINISHES FROM DAMAGE OR UNNECESSARY SOILING THROUGHOUT THE DURATION OF CONSTRUCTION. ALL MATERIAL DAMAGED BY THE CONTRACTOR SHALL BE REPLACED BY THE CONTRACTOR AT NO COST TO THE OWNER.

THE CONTRACTOR SHALL FIELD MEASURE ALL DISTANCES AND CLEARANCES PRIOR TO COMMENCEMENT OF NEW WORK OR ORDERING OF MATERIALS. ANY DEVIATIONS TO THE CONTRACT DRAWINGS SHALL BE REPORTED TO THE ARCHITECT PRIOR TO PROCEEDING WITH THAT PORTION OF WORK. CONTRACTOR SHALL NOT SCALE DRAWINGS

THE CONTRACTOR SHALL COORDINATE WITH THE OWNER TO VERIFY WHICH PARTY WILL PAY FOR ALL CONSTRUCTION PERMITS, FEES AND LICENSES AND INSPECTIONS. NECESSARY FOR A PROPER COMPLETION OF ALL WORK ASSOCIATED WITHIN THESE CONSTRUCTION DRAWINGS.

PERFORMANCE OF ALL WORK IS TO BE IN STRICT ACCORDANCE WITH ALL APPLICABLE CODES & ORDINANCES. CONTRACTOR SHALL HAVE ALL APPLICABLE CODE REFERENCES ON SITE AND AVAILABLE TO ALL TRADES.

THE CONTRACTOR SHALL USE ONLY THOSE ENTRANCES AND PARKING FACILITIES ASSIGNED BY THE OWNER FOR SITE ACCESS. ALL MATERIAL DELIVERIES AND DEMOLITION / TRASH SHALL BE REMOVED DAILY.

THE CONTRACTOR SHALL ENSURE THAT ALL EXISTING / NEW CONSTRUCTION WILL BE SHELTERED FROM DAMAGE BY WEATHER AT ALL TIMES DURING THE CONSTRUCTION ,

THE CONTRACTOR SHALL BE RESPONSIBLE FOR MAINTAINING THE INTEGRITY OF ALL EXISTING FIRE RATED WALLS AND FIRE / SMOKE BARRIERS, TO INCLUDE REPARATION OF NEW AND EXISTING DAMAGE AND / OR PENETRATIONS. CONTRACTOR SHALL REFER TO LATEST EDITION OF THE U.L. FIRE RESISTANCE DIRECTORY FOR SPECIFIC REQUIREMENTS OF THE RATED WALL ASSEMBLY U.L. DESIGN NUMBER AS INDICATED ON THE PARTITION TYPES IN THESE DOCUMENTS. FIRE SEALING OF PENETRATIONS

SHALL CONFORM TO THE SPECIFIC U.L. THROUGH PENETRATION FIRESTOP SYSTEM AS

COORDINATED WITH THE RATED WALL ASSEMBLY U.L. DESIGN NUMBER ALL SMOKE AND FIRE RATED WALLS SHALL BE LABELED ABOVE THE CEILING WITH RED, PAINTED STENCILED LETTERING IDENTIFYING THE APPLICABLE WALL RATING AND STATING EITHER "FIRE AND SMOKE BARRIER - PROTECT ALL OPENINGS" AT SMOKE AND FIRE RATED WALLS OR "FIRE BARRIER - PROTECT ALL OPENINGS" AT FIRE RATED WALLS. STENCILED LABELING SHALL OCCUR ON BOTH SIDES OF EACH SMOKE AND FIRE RATED WALL AT NOT MORE THAN 15 FEET ON CENTER AND ALL WALL TERMINATION OR CHANGES IN DIRECTION SHALL BE DESIGNATED WITH A VERTICAL LINE PER FBCB

THE CONTRACTOR SHALL COORDINATE ELECTRICAL AND MECHANICAL SUBCONTRACTORS AS RELATES TO SCOPE OF ELECTRICAL WORK ASSOCIATED WITH THE COMPLETE AND FUNCTIONING MECHANICAL SYSTEM, FIRE ALARM SYSTEM WIRING, AND CONTROLS WIRING REQUIRED BY THE MECHANICAL DRAWINGS AND NOT INDICATED ON THE ELECTRICAL DRAWINGS. CONTRACTOR SHALL ALLOW IN BID FOR COST OF ELECTRICAL WORK NECESSARY TO COMPLETE INDICATED WIRING &

TERMINATIONS. ALL EXPOSED WOOD AND / OR WOOD IN NON-PROTECTED CONCEALED SPACES SHALL

BE FIRE RETARDANT TREATED WOOD. THE CONTRACTOR SHALL COORDINATE SIZE AND LOCATION OF PLUMBING PIPING AND FITTINGS SO THAT THEY ARE CONCEALED BEHIND FINISHED SURFACE OF WALL UNLESS SPECIFICALLY NOTED OTHERWISE. CONTRACTOR SHALL NOTIFY THE ARCHITECT IF THERE IS A CONFLICT WITH THE WALL TYPE CALLED FOR IN THE PLAN.

THE CONTRACTOR SHALL COORDINATE WALL DEPTH SO THAT ALL ELECTRICAL PANELS AND DEVICES ARE FLUSH MOUNTED IN WALL UNLESS SPECIFICALLY NOTED OTHERWISE. CONTRACTOR SHALL NOTIFY THE ARCHITECT IF THERE IS A CONFLICT WITH THE WALL TYPE CALLED FOR IN THE PLAN.

THE DRAWINGS INCLUDED IN THIS SET ARE DESIGNED AS A COMPLETE SET AND SHALL NOT BE SEPARATED INTO INDIVIDUAL SHEETS OR BY DISCIPLINE. INFORMATION CONTAINED ON ONE SHEET MAY SPECIFICALLY APPLY TO INFORMATION OR CONDITIONS ILLUSTRATED ON OTHER SHEETS. IT IS THE CONTRACTORS RESPONSIBILITY TO VERIFY THAT SUCH ITEMS ARE COORDINATED AND INCLUDED IN

ANY PRICING INFORMATION. PROVIDE CONTINUOUS SEALANT TO PROVIDE "WATER TIGHT" AND "AIR TIGHT" CONDITIONS AT THE PERIMETER OF ALL DOOR FRAMES, INTERIOR WINDOW FRAMES, EXTERIOR WINDOW FRAMES, WINDOW SILLS, CABINETS, CASEWORK, COUNTER TOPS, TOILET ACCESSORIES (BOTH RECESSED AND SURFACE MOUNTED), FIRE EXTINGUISHER CABINETS, FIRE DEPARTMENT VALVE CABINETS, ETC. (EVEN WHEN THE JOINT AT THE

PERIMETER IS EITHER HIDDEN OR NOT CLEARLY VISIBLE). VARIOUS COMPONENTS OF CIVIL, STRUCTURAL, MECHANICAL, ELECTRICAL, PLUMBING AND / OR OTHER SPECIALTIES MAY BE SHOWN IN THE ARCHITECTURAL DRAWINGS FOR INFORMATIONAL PURPOSES ONLY. REFER TO THE RESPECTIVE SPECIALTY DRAWINGS AND SPECIFICATIONS FOR INFORMATION.

THE CONTRACTOR SHALL NOT ALTER, LOAD OR PENETRATE THE STRUCTURE IN ANY MANNER WHICH MAY COMPROMISE ITS INTEGRITY

ANY EXISTING ELECTRICAL, PLUMBING OR HVAC DEVICES OR SYSTEMS WHICH ARE NEEDED TO MAINTAIN THE OPERATIONS OF THE SYSTEM, SHALL BE CAPPED OFF OR REROUTED AS NECESSARY TO MAINTAIN SYSTEM, REGARDLESS IF INDICATED HEREIN. WHEN REMOVING FIXTURES OR DEVICES, REMOVE ALL ASSOCIATED WIRE, BOXES, FRAMING, PIPING OR STRUCTURAL SUPPORT (UNO). SEE ELECTRICAL, HVAC., AND

PLUMBING FOR ADDITIONAL DEMOLITION NOTES, AND DETAILS. ALL BUILDING SYSTEMS (I.E.: WATER, SANITARY, FIRE ALARM, ELECTRIC, ETC.) SHALL REMAIN IN OPERATION THROUGHOUT CONSTRUCTION. ALL NECESSARY INTERRUPTIONS FOR CONNECTION OF NEW WORK SHALL BE PERFORMED AFTER NORMAL BUSINESS HOURS AND APPROVED BY THE OWNER A MINIMUM OF 72 HOURS IN ADVANCE.

THE CONTRACTOR SHALL SCHEDULE ALL WORK TO AVOID INTERRUPTIONS TO ADJACENT AREAS. ALL DISRUPTIVE WORK SHALL BE SCHEDULED AND PERFORMED BEFORE / AFTER NORMAL BUSINESS HOURS. WORK STOPPAGE DUE TO VIBRATIONS, ETC. THAT DISTURB THE OCCUPANTS SHALL BE COORDINATED WITH THE OWNER AND MAY NOT BE GROUNDS FOR ADDITIONAL CHARGES OR CHANGE ORDERS. CONTRACTOR TO COMPLY WITH FBC 8TH EDITION (2023) - 449.3.4.8 REQUIRING 4"

CLEARANCE BETWEEN CONDUITS, PIPING AND DUCTWORK PARALLEL OR ADJACENT TO FIRE AND FIRE SMOKE RATED WALLS AND BARRIERS. APPLICABLE STANDARDS OF THE CONSTRUCTION INDUSTRY HAVE THE SAME FORCE AND EFFECT ON PERFORMANCE OF THE WORK AS IF COPIED DIRECTLY INTO CONTRACT DOCUMENTS OR BOUND AND PUBLISHED HEREWITH. COMPLY WITH

STANDARDS IN EFFECT AS OF THE DATE OF CONTRACT DOCUMENTS, UNLESS OTHERWISE INDICATED. CONTRACTOR TO FURNISH & INSTALL APPROPRIATE METAL (16 GA MIN) AND / OR WOOD BLOCKING REQUIRED FOR EQUIPMENT, ACCESSORIES, RAILINGS AND "BY

OTHERS" ITEMS. BLOCKING SHALL BE CONSTRUCTED TO SUPPORT THE IMPOSED LOAD.

COORDINATION

THE INFORMATION RELATING TO EXISTING CONDITIONS CONTAINED IN THESE PLANS IS BASED ON INFORMATION FURNISHED BY OTHERS AND LIMITED FIELD OBSERVATIONS OF VISIBLE BUILDING ELEMENTS. CONCEALED CONDITIONS MAY VARY SIGNIFICANTLY FROM WHAT IS DEPICTED HEREIN.

PUNCHLIST REQUIREMENTS

- UPON COMPLETION OF THE WORK, CONTRACTOR SHALL INSPECT THEIR WORK AND PREPARE ITEMIZED, DATED PUNCH LIST(S) OF ITEMS REQUIRING CORRECTIVE ACTION.
- WHEN THE CONTRACTOR HAS PERFORMED HIS CORRECTIVE ACTIONS AND VERIFIED COMPLETION OF EACH ITEM, CONTRACTOR SHALL SIGN OFF, AND DATE EACH ITEM.
- UPON COMPLETION OF ITEM 2 ABOVE, THE CONTRACTOR WILL FORWARD A COPY OF SAID PUNCH LIST(S) TO THE DESIGN TEAM FOR REVIEW PRIOR TO THE ASSOCIATED SITE VISIT. ONCE NOTIFIED, THE DESIGN TEAM WILL SCHEDULE THEIR SITE VISIT WITHIN 7 DAYS. THE DESIGN TEAM WILL NOT SCHEDULE THEIR SITE VISIT WITHOUT REVIEWING THE CONTRACTORS COMPLETED PUNCH LISTS REFERENCED IN NOTE 1.
- UPON COMPLETION OF THEIR INSPECTION, THE ARCHITECT SHALL FORWARD THE PUNCH LIST(S) TO THE CONTRACTOR.
- THE CONTRACTOR SHALL CORRECT THESE ITEMS WITHIN WITHIN A MUTUALLY AGREED TIME PERIOD.
- UPON COMPLETION OF ITEM 5 ABOVE, THE CONTRACTOR SHALL VERIFY THAT ALL CORRECTIVE ACTION HAS BEEN COMPLETED AND RETURN THE PUNCH LIST WITH CONTRACTOR'S SIGN OFF, AND DATE OF REINSPECTION TO THE ARCHITECT.
- THE DESIGN TEAM RESERVES THE RIGHT TO DEEM THE PROJECT "NOT READY FOR PUNCH LIST" IF THERE ARE MULTIPLE, SIMILAR OR REPETITIVE DEFICIENCIES OBSERVED. IN THIS CASE THE DESIGN TEAM MAY PREPARE A GENERAL PUNCH LIST BASED OFF THESE OBSERVATIONS AND ISSUE TO THE CONTRACTOR. THE CONTRACTOR SHALL REVISIT EACH SPACE TO CORRECT AND VERIFY THAT THESE ITEMS ARE COMPLETE PRIOR TO REQUESTING THAT THE ARCHITECT AND/OR CONSULTING TEAM RETURN TO PREPARE A PUNCH LIST.
- MULTIPLE VISITS BY THE DESIGN TEAM TO VERIFY COMPLETION OF ITEMS ON THE PUNCH LIST MAY BE CLASSIFIED AS ADDITIONAL SERVICES AND BILLED TO THE OWNER ACCORDINGLY

PERMITTING

TO THE BEST OF THE ARCHITECT'S KNOWLEDGE THE PLANS COMPLY WITH THE MINIMUM APPLICABLE CODES.

APPLICABLE CODES

FLORIDA BUILDING CODE (FBC) 8TH EDITION (2023)

FLORIDA BUILDING CODE – ACCESSIBILITY 8TH EDITION (2023) FLORIDA BUILDING CODE - BUILDING 8TH EDITION (2023) FLORIDA BUILDING CODE – ENERGY CONSERVATION 8TH EDITION (2023) FLORIDA BUILDING CODE – EXISTING BUILDING 8TH EDITION (2023) FLORIDA BUILDING CODE - FUEL GAS 8TH EDITION (2023) FLORIDA BUILDING CODE - MECHANICAL 8TH EDITION (2023)

FLORIDA FIRE PREVENTION CODE 8TH EDITION (2023)

NFPA 1 FIRE CODE 2021 EDITION

NFPA 101 LIFE SAFETY CODE 2021 EDITION NFPA 13 STANDARD FOR THE INSTALLATION OF SPRINKLER SYSTEMS 2019 EDITION

FLORIDA BUILDING CODE - PLUMBING 8TH EDITION (2023)

NFPA 70 NATIONAL ELECTRIC CODE 2020 EDITION NFPA 72 NATIONAL FIRE ALARM & SIGNALING CODE 2019 EDITION

STATE FIRE MARSHAL'S RULE 69A-58 FAC

NOA / FLORIDA PRODUCT APPROVAL / SPECIALTY ENGINEERING

REVIEW AND APPROVAL REQUIRED

CONTRACTOR SHALL SUBMIT NOA, FLORIDA PRODUCT APPROVAL OR SIGNED AND SEALED SPECIALTY ENGINEERING DOCUMENTS FOR THE INSTALLATION AND ATTACHMENT OF ANY ITEM EXPOSED TO WIND LOADS, INCLUDING BUT NOT LIMITED TO: DOORS, WINDOWS, GUTTERS, LIGHT FIXTURES, ROOF VENTILATORS, ROOF MOUNTED MECHANICAL EQUIPMENT, LP TANKS, GENERATORS ETC...

THE RESPONSIBLE DESIGN PROFESSIONAL SHALL REVIEW NOA / FLORIDA PRODUCT APPROVAL OR SIGNED AND SEALED SPECIALTY ENGINEERING SUBMISSIONS, RETURN TO THE CONTRACTOR AND THE CONTRACTOR SHALL FORWARD TO THE DISTRICT BUILDING CODE SERVICES DEPARTMENT FOR FINAL APPROVAL. ACTIONS TAKEN OR WORK ACCOMPLISHED PRIOR TO FINAL APPROVAL ARE DONE AT RISK.

SHOP DRAWINGS / PRODUCT DATA / FIELD VERIFICATION

THE CONTRACTOR SHALL FIELD VERIFY DIMENSIONS AND EXISTING CONDITIONS VERSUS WHAT IS SHOWN IN THESE DOCUMENTS PRIOR TO SUBMITTAL OF SHOP DRAWINGS / PRODUCT DATA, FABRICATION, ORDERING OR INSTALLATION OF ANY ITEMS. ON EXISTING FACILITIES, THIS INCLUDES ROOF MOUNTED ITEMS AND ABOVE CEILING ITEMS (SUCH AS FANS) AND ANY ITEMS THAT MAY BE CONCEALED. THE CONTRACTOR SHALL NOTIFY THE ARCHITECT OF ANY DISCREPANCIES BETWEEN WHAT IS SHOWN IN THESE DOCUMENTS VERSUS WHAT IS EXISTING IN THE FIELD PRIOR TO THE SUBMITTAL OF SHOP DRAWINGS / PRODUCT DATA, FABRICATION, ORDERING OR INSTALLATION OF ANY ITEMS.

EXISTING UTILITIES

- THE CONTRACTOR SHALL OBTAIN A SUNSHINE STATE ONE CALL CENTER CERTIFICATION NUMBER AT LEAST 48 HOURS PRIOR TO BEGINNING ANY EXCAVATION. (CALL SUNSHINE 1-800-638-4097)
- PRIOR TO BEGINNING CONSTRUCTION, THE CONTRACTOR SHALL VERIFY THE SIZE, LOCATION, ELEVATION, AND MATERIAL OF ALL EXISTING UTILITIES WITHIN THE AREA OF CONSTRUCTION BY USE OF RECORD DRAWINGS AND / OR ELECTRONIC LOCATING
- EXISTING UTILITY LOCATIONS SHOWN ON THE PLANS ARE APPROXIMATE AND BASED
- THE CONTRACTOR IS RESPONSIBLE FOR VERIFYING ALL UTILITIES, AND NOTIFYING THE ARCHITECT OF CONFLICTS AND VARIATIONS.
- THE CONTRACTOR IS RESPONSIBLE FOR DAMAGE TO ANY EXISTING UTILITIES FOR WHICH HE FAILS TO REOUEST LOCATIONS FROM THE UTILITY OWNER, AND FOR DAMAGE TO EXISTING UTILITIES THAT ARE PROPERLY LOCATED.
- THE CONTRACTOR SHALL IMMEDIATELY NOTIFY THE ARCHITECT, IF UPON EXCAVATION FINDS THE EXISTING UTILITY IN CONFLICT WITH THE PROPOSED CONSTRUCTION OR OF A DIFFERENT SIZE OR MATERIAL FROM THAT SHOWN ON THE PLANS.

VERIFICATION OF EXISTING CONDITIONS

THE CONTRACTOR SHALL VERIFY EXISTING UTILITIES, SERVICES, ARCHITECTURAL, MECHANICAL, ELECTRICAL AND PLUMBING ITEMS AND ELEMENTS ARE AS SHOWN IN THE PLANS. WHERE EXISTING ITEMS ARE IDENTIFIED IN THE PLANS TO BE REPLACED, THE CONTRACTOR SHALL FIELD VERIFY THE LOCATION, TYPE AND SIZE OF THE EXISTING ITEM MATCHES THAT SHOWN ON THE PLANS. THIS INCLUDES, BUT IS NOT LIMITED TO: DOORS, WINDOWS, HARDWARE, EXHAUST FANS, ROOF MOUNTED EQUIPMENT, ABOVE CEILING EQUIPMENT AND VERIFICATION THAT NEW ITEM IS COMPATIBLE WITH THE EXISTING VOLTAGE AND AMPERAGE. NOTIFY ARCHITECT OF ANY DISCREPANCIES PRIOR TO CONSTRUCTION. ADDITIONAL COSTS SHALL NOT BE CONSIDERED UNLESS CONFLICTS OR DISCREPANCIES ARE BROUGHT TO THE ARCHITECT'S ATTENTION PRIOR TO SUBMITTAL OF SHOP DRAWINGS AND **FABRICATION / PROCUREMENT.**

CONCEALED CONDITIONS

CONTRACTOR SHALL NOTIFY THE ARCHITECT OF ANY CONFLICTS IN THE DRAWINGS PRIOR TO CONSTRUCTION. CONTRACTOR WILL NOT BE PAID FOR EXTRA WORK RESULTING FROM POOR COORDINATION BY THE CONTRACTOR.

PROJECT MANAGEMENT APPLICATIONS/SOFTWARE

IT WILL BE AT THE ARCHITECT'S SOLE DISCRETION IF AND HOW THEY WILL PARTICIPATE IN THE USE OF THE CONTRACTOR'S PROJECT MANAGEMENT SOFTWARE FOR ANY AND ALL DESIGN TEAM RESPONSIBILITIES, INCLUDING, BUT NOT LIMITED TO: RFIS, SUBMITTALS, PUNCH LIST.



CITY OF GREENACRES 5800 MELALEUCA LANE GREENACRES, FL, 33463

ARCHITECT

ARCHITECTURE CONSTRUCTION AA26001115 EB28211 CGC1504260

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GREENACRES, FL 33463 T: 561-649-6705

CONSULTANT

PROJECT TITLE

FIRE RESCUE STATION 95 LOUNGE RENOVATION

5095 HAVERHILL RD, GREENACRES, FL 33463

PROJECT ADDRESS

SUBMITTAL HISTORY No. DATE DESCRIPTION

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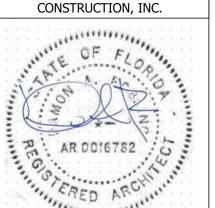
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AT SUCH ITEMS ARE COORDINATED AND INCLUDED IN ANY PRICING INFORMATION. FIELD VERIFY AND NOTIFY THE ARCHITECT OF ANY DEVIATIONS

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FROM THE PLANS AND / OR SPECS

PRIOR TO CONSTRUCTION




DIGITAL SEAL

PROJECT NUMBER

585-2024-01 SHEET TITLE

NOTES, ABBREVIATIONS & LEGEND

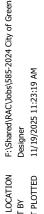

ROOM FINISH SCHEDULE												
ROOM				WALLS			DOORS					
NUMBER	ROOM NAME	FLOOR	BASE	NORTH	SOUTH	EAST	WEST	PANEL	FRAME	CEILING	MISCELLANEOUS	REMARKS
100	HALLWAY	F1	B1	W1	W1	W1	W1	D1	D2	C1		1
101	LOUNGE 1	F1	B1	W1	W1	W1	W1	D1	D2	C1		
102	LOUNGE 2	F1	B1	W1	W1	W1	W1	D1	D2	C1		
103	LOUNGE 3	F1	B1	W1	W1	W1	W1	D1	D2	C1		
104	LOUNGE 4	F1	B1	W1	W1	W1	W1	D1	D2	C1		
105	LOUNGE 5	F1	B1	W1	W1	W1	W1	D1	D2	C1		
106	LOUNGE 6	F1	B1	W1	W1	W1	W1	D1	D2	C1		
REMARKS												

REFER TO DOOR SCHEDULE ON SHEET A8.1 FOR MORE INFORMATION.

FINISH MATERIAL LEGEND

COORDINATE WITH OWNER AND TENANT TO IDENTIFY WALLS.

FINISHES GENERAL NOTES

ALL FINISHES TO BE LOW V.O.C.

ALL SPECIFIED FINISHES ARE "OR APPROVED EQUAL". CONTRACTOR TO SUBMIT FOR

PROVIDE APPROPRIATE ADA COMPLIANT THRESHOLDS/ TRANSITION STRIP WHERE

ALL WALLS SHALL BE PREPARED TO A LEVEL III FINISH AND PAINTED WITH THE COLOR & SHEEN SPECIFIED IN THE FINISH SCHEDULE. ALL PAINTED SURFACES SHALL BE PRIME

FLOOR CHANGES MATERIAL. SUBMIT TO OWNER/TENANT FOR APPROVAL

D PRIOR TO THE APPLICATION OF A MINIMUM OF 2 FINISH COATS OF PAINT.

FLOORING F1

ARMSTRONG WASHED LINEN, 51810

BASE

RUBBER BASE TARKETT

TRADITIONAL WALL BASE, 281, GRIZZLY CB

WALLS W1 PAINT

SHERWIN WILLIAMS

SEDATE GRAY, SW6169, EGGSHELL

DOORS

D1 PAINT

SHERWIN WILLIAMS

GREEK VILLA, SW7551, SEMIGLOSS

D2

SHERWIN WILLIAMS

GREEK VILLA, SW7551, SEMIGLOSS


CEILING

ARMSTRONG

PAINT

ULTIMA, TEGULAR, FINE TEXTURE, WHITE, 2X2

SUPRAFINE XL, EXPOSED TEE SUSPENSION SYSTEM, WHITE

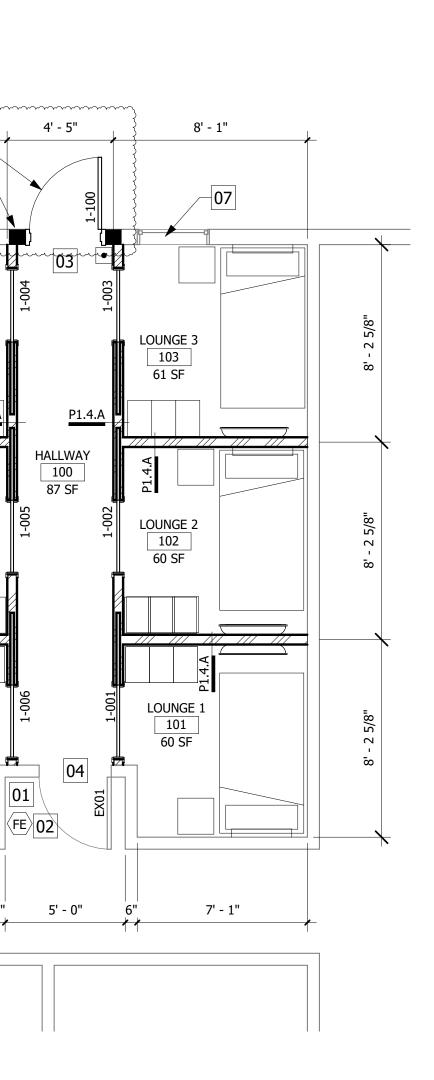


7' - 8"

LOUNGE 4

LOUNGE 5

LOUNGE 6

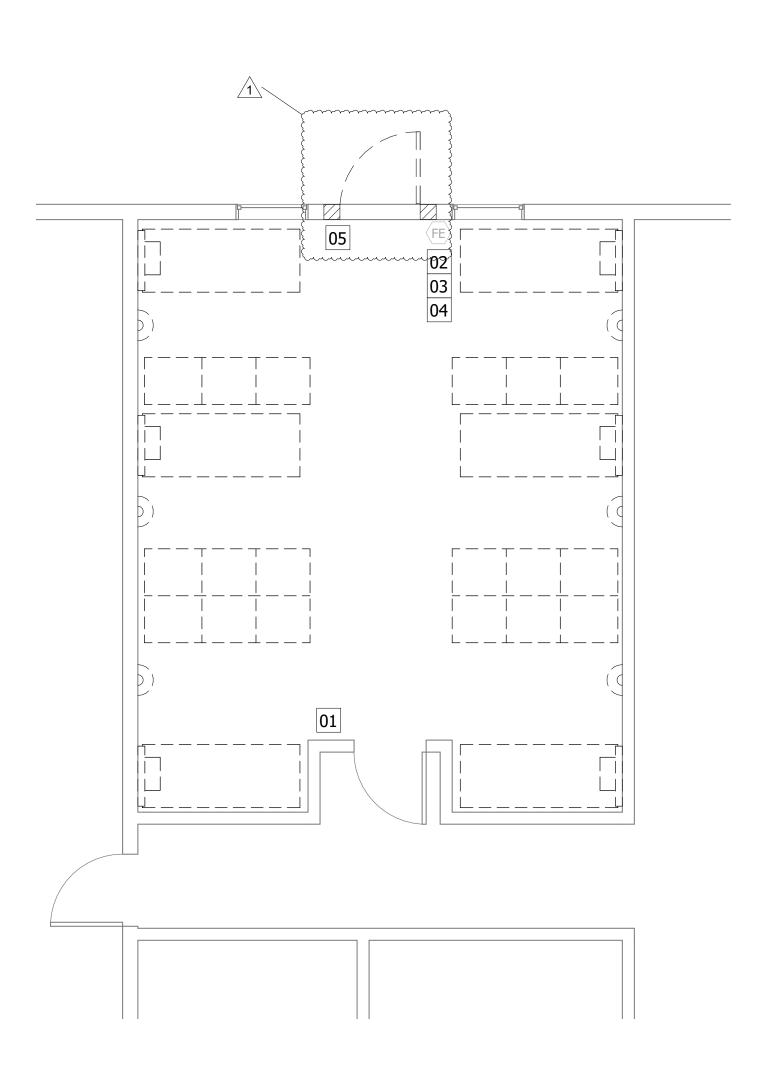

NEW WORK GENERAL NOTES

- CONTRACTOR TO VERIFY ALL FIELD CONDITIONS PRIOR TO COMMENCEMENT AND REPORT ANY DISCREPANCIES TO THE ARCHITECT.
- REPAIR ANY DAMAGE TO EXISTING CONDITIONS OCCURRED DURING CONSTRUCTION.
- REFER TO SHEET A6.1 FOR PARTITION/WALL DETAILS.
- REFER TO SHEET A8.1 FOR DOOR DETAILS AND SCHEDULE.
- ALL PIPE PENETRATIONS THROUGH RATED PARTITIONS MUST MEET UL APPROVED STANDARDS. SUBMIT SYSTEM TO ARCHITECT FOR APPROVAL.
- PROVIDE SOLID WOOD BACKING FOR ALL WALLS TO RECEIVE TV MOUNTS. THE INSTALLATIONS SHALL BE REVIEWED BY THE ARCHITECT PRIOR TO COVERING. CONCEALED WOOD SHALL BE FIRE RETARDANT TREATED.
- INSTALL NEW VCT FLOORING & WALL BASE AS SCHEDULED.
- PROVIDE INTERIOR SIGNS AT NEW AND EXISTING DOORS IN AREA OF WORK TO MATCH BUILDING STANDARDS. REFER TO SHEET A6.1 FOR MORE INFORMATION.

NEW WORK KEYNOTES

01 REINSTALL WALL MOUNTED PHONE.

02 REINSTALL FIRE EXTINGUISHER.

03 REINSTALL EMERGENCY WALL PACK LIGHT FIXTURE ABOVE EXISTING EXIT EGRESS DOOR, WALL MOUNTED. ENSURE FIXTURE IS BELOW EXIT SIGN.

04 INSTALL NEW ADA TRANSITION.

05 ACCESS CONTROL KEYPAD. MOUNTED AT FBC ADA COMPLIANT HEIGHT.

06 INSTALL NEW DOOR, FRAME AND HARDWARE 07 NEW UBLOCKOUT ULTIMATE BLACKOUT SHADE WINDOW TREATMENT BLACKOUT ROLLER


WITH SIDE AND BOTTOM BAR 07 NEW UBLOCKOUT ULTIMATE BLACKOUT SHADE WINDOW TREATMENT BLACKOUT ROLLER

WITH SIDE AND BOTTOM BAR

NEW WORK LEGEND

THE CONTRACTOR SHALL FURNISH AND INSTALL ALL REQUIRED EQUIPMENT, WIRING, AND ASSOCIATED COMPONENTS NECESSARY TO ENSURE PROPER FUNCTIONALITY, IN ACCORDANCE WITH THE INTENDED DESIGN AND THE SPECIFIC REQUIREMENTS PROVIDED BY THE END-USER.

CONTRACTOR TO PROVIDE AN ADDITIONAL SET OF EACH (1) BED, (1) NIGHTSTANDS, (3) LOCKERS. THE EXTRA SET WILL NEED TO BE INSTALLED ELSEWHERE COORDINATE WITH OWNER.

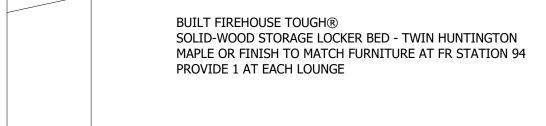

HUNTINGTON MAPLE OR FINISH TO MATCH FURNITURE AT FR STATION 94 - PROVIDE 3 AT EACH LOUNGE

SALSBURY INDUSTRIES MAPLE 12"W X 18"D X 72"H -

BUILT FIREHOUSE TOUGH® SOLID-WOOD OPEN NIGHTSTAND WITH SIDE PANELS -HUNTINGTON MAPLE OR FINISH TO MATCH FURNITURE AT FIRE STATION 94 - PROVIDE 1 AT EACH LOUNGE

WALL MOUNTED FLAT TV ONN 32" ROKU TV OUTLET AT 44" AFF, TV TO BE MOUNTED CENTER TO OUTLET. PROVIDE 1 AT EACH LOUNGE WITH TV MOUNT

INTERIOR POCKET DOOR

WALL SCONCE WAC LIMITED, METRO BATH & VANITY, WS-18120-30-BN

ADA EXIT PUSH BUTTON BEA, SQUARE WITH TEXT AND LOGO, 10EMS4751 MOUNTED AT FBC ADA COMPLIANT HEIGHT.

DEMOLITION GENERAL NOTES

- ALL DEMOLITION WORK SHALL BE EXECUTED IN AN ORDERLY AND CAREFUL MANNER WITH DUE CONSIDERATION FOR ANY EXISTING BUILDING OR SITE ELEMENTS. EXTREME CAUTION SHALL BE EXERCISED TO INSURE THAT ABSOLUTELY NO DAMAGE OCCURS TO ITEMS WHICH ARE TO REMAIN, INCLUDING CONCEALED AND / OR SUBSURFACE ITEMS / UTILITIES. CONTRACTOR SHALL REPLACE OR REPAIR ANY DAMAGE CAUSED BY CONSTRUCTION ACTIVITIES OR CLEANUP.
- THE CONTRACTOR SHALL VISIT THE SITE AND COMPLETELY EXAMINE THE EXISTING CONDITIONS AND EXTENT OF THE WORK INVOLVED PRIOR TO BIDDING AND CONSTRUCTION.
- PORTIONS OF THE EXISTING BUILDING SITE MAY BE OCCUPIED DURING DEMOLITION WORK. CONTRACTOR SHALL MAINTAIN ALL REQUIRED EXITS AND LIFE SAFETY DEVICES DURING THE ENTIRE CONSTRUCTION PROCESS.
- REMOVE ALL FURNITURE AND EQUIPMENT FROM WORK AREA. COORDINATE WITH OWNER FOR STORAGE OF SALVAGEABLE ITEMS OR DISPOSAL.
- REMOVE EXISTING WALL MOUNTED DEVICES/LIGHTING, UNO. CONTRACTOR SHALL COVER ALL EXISTING WALL MOUNTED DEVICES THAT REMAINS, TO PROTECT FROM DUST AND DAMAGE.
- REMOVE FLOORING, BASE, AND ASSOCIATED ADHESIVE / SETTING MATERIALS. REPAIR SUBSTRATES.

DEMOLITION KEYNOTES

01 RELOCATE WALL MOUNTED PHONE. REFER TO NEW WORK PLAN FOR LOCATION.

04 RELOCATE EMERGENCY WALL PACK LIGHT FIXTURE. REFER TO NEW WORK PLAN FOR

02 RELOCATE FIRE EXTINGUISHER. REFER TO NEW WORK PLAN FOR LOCATION. 03 REMOVE FA STROBE AND PULL STATION. REFER TO ELECTRICAL DRAWINGS FOR NEW



02 NEW WORK PLAN

1/4" = 1'-0"

DEMOLITION PLAN

1/4" = 1'-0"

OWNER

CITY OF GREENACRES 5800 MELALEUCA LANE GREENACRES, FL, 33463

ARCHITECT

CONSTRUCTION AA26001115 EB28211 CGC1504260 101 WALKER AVE.

ARCHITECTURE

GREENACRES, FL 33463 T: 561-649-6705 WWW.ROBLING.COM

CONSULTANT

PROJECT TITLE

FIRE RESCUE STATION 95 LOUNGE RENOVATION PROJECT ADDRESS

5095 HAVERHILL RD, GREENACRES, FL 33463

SUBMITTAL HISTORY No. DATE DESCRIPTION

10/29/25 OWNER REVISIONS

THE DRAWINGS AND SPECIFICATIONS INCLUDED OR


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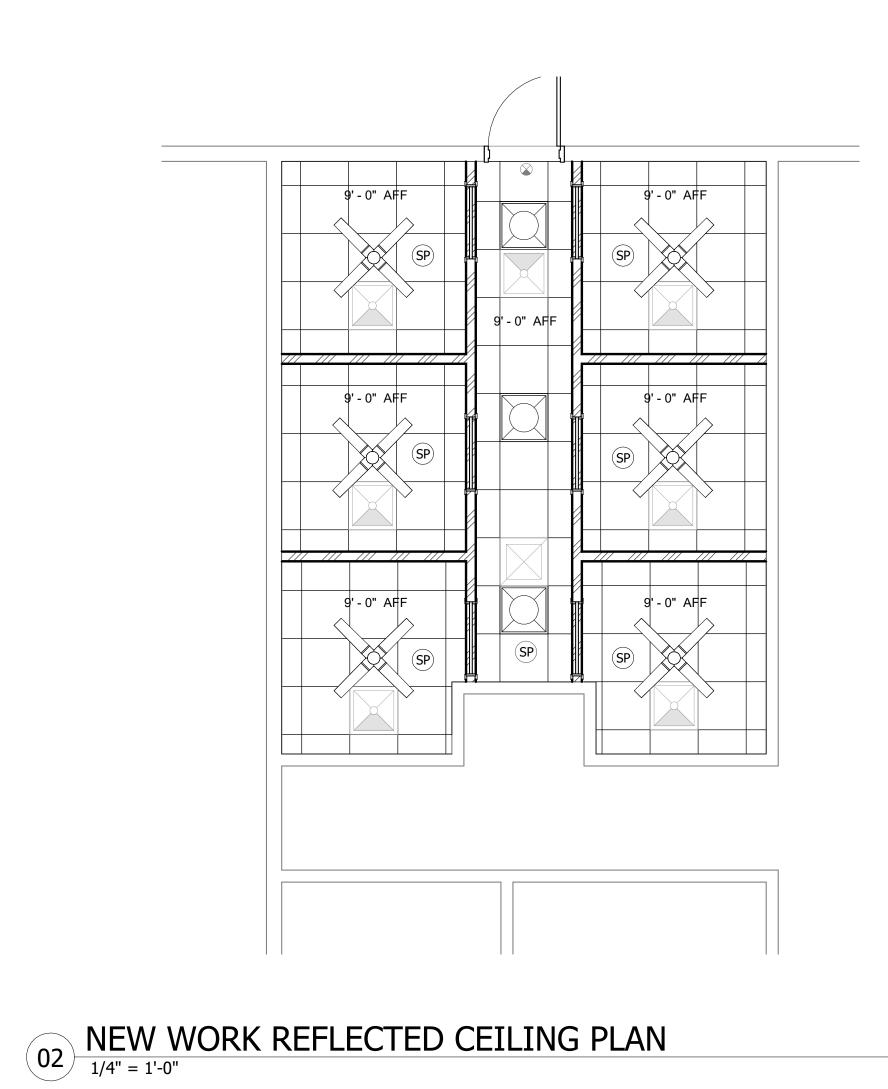
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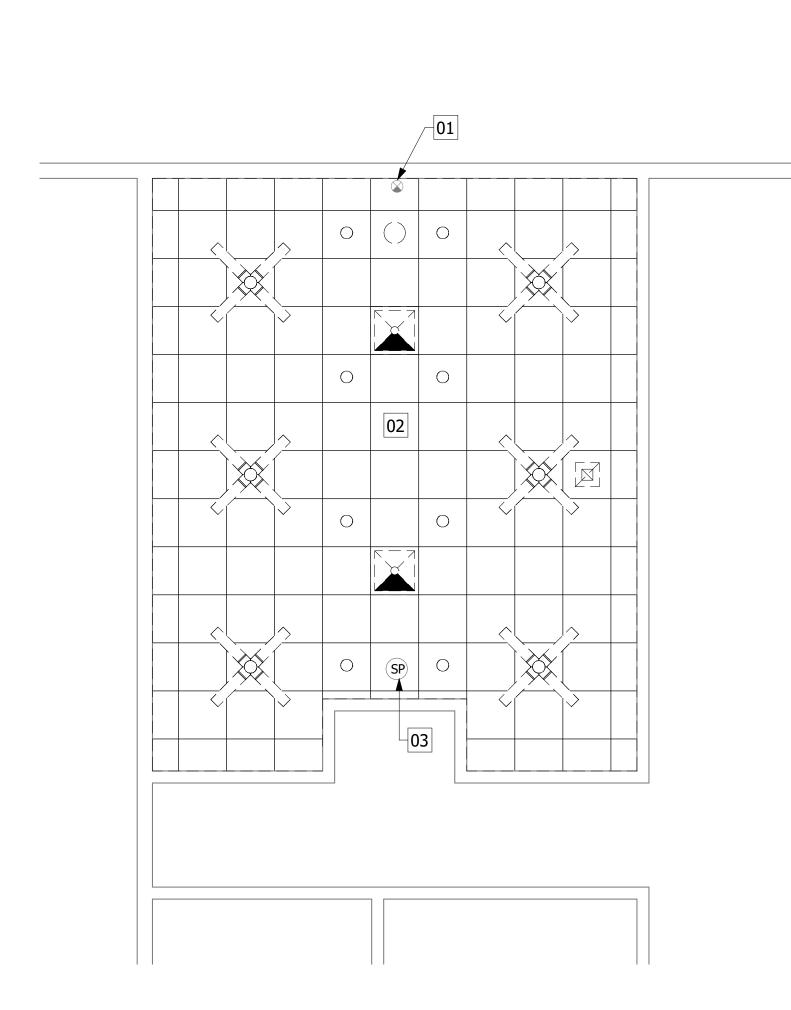
PROJECT NUMBER 585-2024-01

SHEET TITLE

SHEET NUMBER

FLOOR PLANS



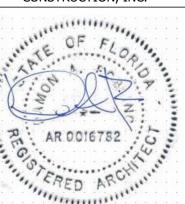




NEW WORK GENERAL NOTES

- ALL CEILING MOUNTED DEVICES, INCLUDING LIGHTS, HVAC REGISTERS AND EXHAUST FANS SHALL BE CENTERED IN THE TILE. ANY CONFLICTS SHALL BE REPORTED TO THE ARCHITECT UPON DISCOVERY. UNDER NO CIRCUMSTANCES SHALL ANY ITEM BE RELOCATED WITHOUT THE ARCHITECTS APPROVAL.
- REPAIR ANY DAMAGE TO EXISTING CONDITIONS OCCURRED DURING CONSTRUCTION.
- ALL CEILING FIXTURES SHOULD BE COORDINATED WITH MECHANICAL AND ELECTRICAL DRAWINGS TO AVOID CONFLICTS.
- CONTRACTOR TO COORDINATE VARIOUS TRADES TO AVOID ABOVE CEILING CONFLICTS.
- RELOCATE FIRE SPRINKLERS AS NEEDED TO ALIGN WITH THE NEW WORK PLAN. REFER TO FIRE PROTECTION DRAWINGS.
- INSTALL NEW LIGHT FIXTURES. REFER TO LEGEND BELOW.
- INSTALL NEW CEILINGS AS SCHEDULED. REFER TO SHEET A1.1 FOR FINISH SCHEDULE
- COORDINATE WITH MEP PLANS FOR ADDITIONAL CEILING MOUNTED DEVICES

NEW WORK RCP LEGEND

THE CONTRACTOR SHALL FURNISH AND INSTALL ALL REQUIRED EQUIPMENT, WIRING, AND ASSOCIATED COMPONENTS NECESSARY TO ENSURE PROPER FUNCTIONALITY, IN ACCORDANCE WITH THE INTENDED DESIGN AND THE SPECIFIC REQUIREMENTS PROVIDED BY THE END-

EXISTING CEILING MOUNTED ILLUMINATED EXIT SIGN

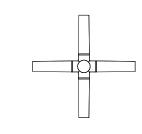

HOMMEE 52 IN. INDOOR MATTE BLACK LOW PROFILE CEILING FAN WITH INTEGRATED LED LIGHT KIT.



DAY-BRITE FLUX PANEL SELECTABLE LED 2X2 RECESSED LIGHT

CEILING MOUNTED SPEAKER FOR EACH ROOM WITH VOLUME CONTROL SPECO TECHNOLOGIES MODEL SPG66TC: 18 AWG STANDARD OR BETTER SPEAKER WIRE SHOULD SUFFICE.

DEMOLITION GENERAL NOTES

- REFER TO MEP FOR ADDITIONAL INFORMATION.
- REMOVE LAY-IN CEILING TILE AND GRID, CEILING MOUNTED DEVICES AND LIGHTING, UNO. CONTRACTOR SHALL COVER ALL EXISTING CEILING MOUNTED EQUIPMENT THAT REMAINS, TO PROTECT FROM DUST AND DAMAGE.

DEMOLITION KEYNOTES



CEILING MOUNTED, ILLUMINATED EXIT SIGN TO REMAIN.

ABOVE CEILING INSULATION TO REMAIN. CEILING MOUNTED SPEAKER TO REMAIN.

OWNER

CITY OF GREENACRES 5800 MELALEUCA LANE GREENACRES, FL, 33463

ARCHITECT

ARCHITECTURE CONSTRUCTION AA26001115 EB28211 CGC1504260

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WWW.ROBLING.COM

CONSULTANT

PROJECT TITLE

FIRE RESCUE STATION 95 LOUNGE RENOVATION

PROJECT ADDRESS 5095 HAVERHILL RD,

GREENACRES, FL 33463 SUBMITTAL HISTORY

No. DATE DESCRIPTION

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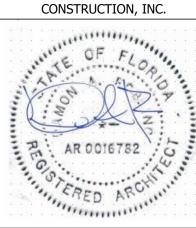
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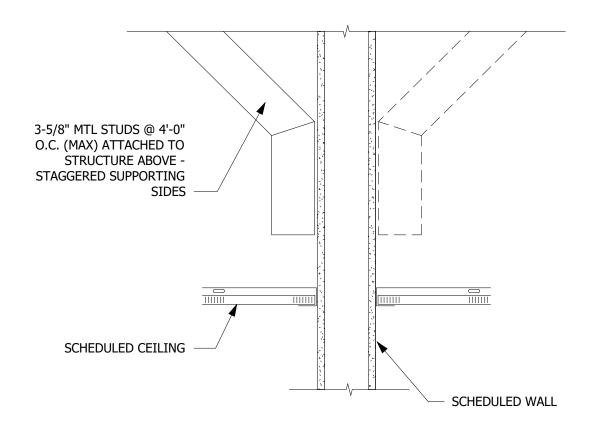
SHEET TITLE

REFLECTED CEILING PLANS

WALL CONTROL JOINTS


SOUND ATTENUATION

FIRE BLANKET




NON-RATED WALL


CONTROL JOINT

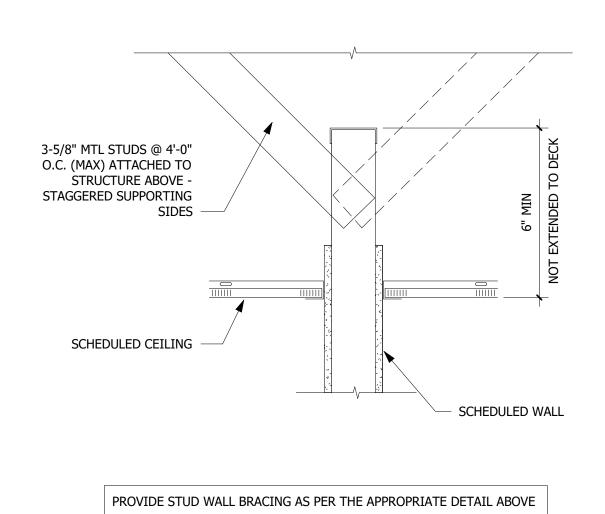



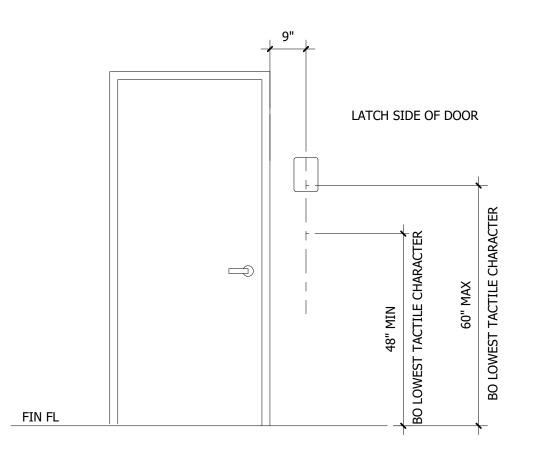



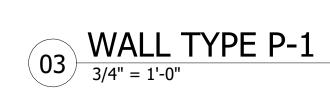

REFER TO DETAIL

APPROPRIATE WALL

FLOOR/ROOF DECK

SCHED CEILING

ACOUSTICAL BATT

INSULATION WITH

SCHED FLOORING

STC RATING 50

01/A6.1 FOR

BRACING TO

GWB W/ WALL FINISH

METAL STUDS -

SCHED BASE

SCHED FLOORING

SIZE PER WALL TAG

ROOM SIGNAGE NOTES

- ALL NEW SIGNS SHALL MATCH EXISTING SIGNS. COORDINATE WITH OWNER.
- SIGNAGE COLOR SAMPLES SHALL BE SUBMITTED FOR OWNER'S AND ARCHITECT'S APPROVAL.
- ALL DOOR SIGNS TO HAVE BRAILLE INSCRIPTIONS. LETTERS, NUMBERS AND CARICATURES TO BE RAISED 1/8" MN. FONT TYPE TO BE ARIAL, UNO.
- SUBMIT SHOP DRAWINGS FOR APPROVAL BY OWNER AND ARCHITECT PRIOR TO
- ALL SIGNS TO MEET A.D.A. AND FLORIDA ACCESSIBILITY CODE REQUIREMENTS.
- ROOM NUMBER SEQUENCE TO BE VERIFIED BY OWNER. ROOM NUMBERS DOES NOT HAVE TO MATCH WITH ARCHITECTURAL PLAN ROOM NUMBERS.

GENERAL NOTES

- THESE WALL & PARTITION TYPES ARE DIAGRAMMATIC IN NATURE REFER TO BUILDING SECTIONS AND FIRE RESISTIVE DESIGNS FOR ADDITIONAL INFORMATION.
- WALL TAG DESIGNATION IS INTENDED TO INDICATE WALL TYPE ALONG AN ENTIRE WALL PLANE AND/OR SURFACE ALONG THE FULL LENGTH OF A SPACE OR CORRIDOR INCLUDING ASSOCIATED ALCOVES AND NICHES, UNLESS INDICATED OTHERWISE.
- REFER TO LIFE SAFETY PLANS FOR LOCATION AND FULL EXTENT OF FIRE RATED WALLS, CONTRACTOR SHALL BE RESPONSIBLE FOR MAINTAINING ALL WALL RATINGS (AS APPLICABLE).
- WALL FINISH TO EXTEND 4" ABOVE CEILING MINIMUM (UNO).
- IF A CEILING IS NOT REQUIRED IN A SPACE, CONTRACTOR SHALL CONTINUE WALL FINISH TO DECK ABOVE.
- INSULATION SHALL BE ENCAPSULATED BY GWB IN A PLENUM.
- INSULATION PERMITTED TO BE EXPOSED IN A CONCEALED SPACE SHALL HAVE A FLAME SPREAD RATING OF NOT MORE THAN 25.
- LOCATE CONTROL JOINT FOR EVERY 30' OF UNINTERRUPTED STRAIGHT PLANE WALL OR SOFFIT. LOCATE CONTROL JOINT IN CEILINGS OVER 50' LONG OR 2500 SF. CONTRACTOR TO SUBMIT PROPOSED CJ LAYOUT TO ARCH IF NOT SPECIFICALLY DETAILED IN THESE DRAWINGS.
- PROVIDE CEMENT BOARD TO 5'-0" (MIN) AT ALL WET LOCATIONS. ALL GWB IN WET LOCATIONS TO BE MOLD / WATER RESISTANT.
- WALLS AND PARTITIONS WITHIN 2 FEET (610 MM) OF SERVICE SINKS, URINALS AND WATER CLOSETS SHALL HAVE A SMOOTH, HARD, NONABSORBENT SURFACE, TO A HEIGHT OF NOT LESS THAN 4 FEET (1219 MM) ABOVE THE FLOOR, AND EXCEPT FOR STRUCTURAL ELEMENTS, THE MATERIALS USED IN SUCH WALLS SHALL BE OF A TYPE THAT IS NOT ADVERSELY AFFECTED BY MOISTURE PER FBCB - 1210.2.2 (EPOXY PAINT


PARTITION NOTES

- NON-BEARING STUD WALLS ONLY. SEE OTHER DETAILS FOR BEARING WALLS
- ALL STUDS SHALL BE 22 GA (0.283 INCHES) MINIMUM UNLESS UNO. USE SAME GAUGE RUNNERS AND TRACKS AS STUDS. SEE STUD SCHEDULE FOR THICKNESS AND GALVANIZATION REQUIREMENTS.
- PROVIDE DOUBLE 18 GA STUDS AT WINDOW AND DOOR OPENINGS.
- TYPICAL FASTENER, STEEL STUDS TO STEEL STUDS OR TRACKS: #8-18 X 1/2" TEKS 2 WITH PHILIPS PAN HEAD FOR 22 GA. #10-16 X 9/16 TEKS 3 WITH PHILIPS PAN HEAD FOR INTERCONNECT OF 18 GA OR 20 GA.
- STEEL STUDS OR TRACKS TO STRUCTURAL STEEL (TUBE STEEL, WIDE FLANGE COLUMNS, BEAMS, GIRDERS, ETC.): TEKS 3 OR TEKS 4 - GAUGE AND LENGTH AS REQUIRED FOR THE COMBINED THICKNESS OF THE FRAMING TO BE DRILLED.
- METAL TRACK TO CONCRETE: FASTENED TO CONCRETE W/ 3/16" X 1 3/4" EMBEDMENT TAPCONS AT 16" O.C.
- METAL TRACK TO METAL DECK: #8-18 X 1/2" TEKS / 2 WITH PHILIPS PAN HEAD AT 16"
- GWB TO STEEL STUDS: #7 X 1 1/4" HI-LO TYPE S BUGLE HEAD SCREWS FOR 3/8" GWB TO 22 GA OR 20 GA STUDS. #6 X 1 1/4" TYPE S-12 BUGLE HEAD SCREWS FOR 3/8" - 5/8" TO 18 GA OR 16 GA STUDS OR TRACK.
- AT PARTITIONS HIGHER THAN 12'-0", PROVIDE HORIZONTAL LATERAL BRACING W/ 1 1/2" 16 GA COLD-ROLLED CHANNELS AT 8'-0" VERT ANCHORED TO STUDS.
- ALL CONSTRUCTION SUPPORTED BY ROOF STRUCTURE SHALL BE SUPPORTED BY TOP CHORD OF STRUCTURAL JOISTS AND NOT FROM METAL DECK.
- FRAMING AT SHOWERS AND DOOR JAMBS SHALL BE 20 GA. MINIMUM.

RATED WALL NOTES

- RATED STEEL STUD PARTITION WALLS AND WALL EXTENSIONS SHALL BE CONSTRUCTED IN ACCORDANCE WITH UL, GA, W-H, OR FM DESIGN NUMBERS.
- ALL JOINTS & PENETRATIONS OF RATED STEEL STUD PARTITION WALLS AND WALL EXTENSIONS SHALL BE CONSTRUCTED IN ACCORDANCE WITH SYSTEMS INDICATED.
- ALL JOINTS & PENETRATIONS OF RATED MASONRY WALLS SHALL BE CONSTRUCTED IN ACCORDANCE WITH SYSTEMS INDICATED.
- ALL JOINTS & PENETRATIONS OF RATED FLOOR / CEILING ASSEMBLIES SHALL BE CONSTRUCTED IN ACCORDANCE WITH SYSTEMS INDICATED.
- ALL ALTERNATE PENETRATION, JOINTS, HEAD OF WALLS, AND PROTECTION SYSTEMS MUST BE TEST CERTIFIED AND SUBMITTED FOR REVIEW AND APPROVAL.
- PROVIDE 1 HOUR FIRE RATED CONSTRUCTION AND OPENING PROTECTIVES AT ELECTRICAL ROOM WALLS WHEN CONTAINING TRANSFORMER W/ LOAD EXCEEDING 112.5 KVA PER NEC / NFPA 70 SECTION 450 WHETHER OR NOT IT IS INDICATED ON THE

LEGEND

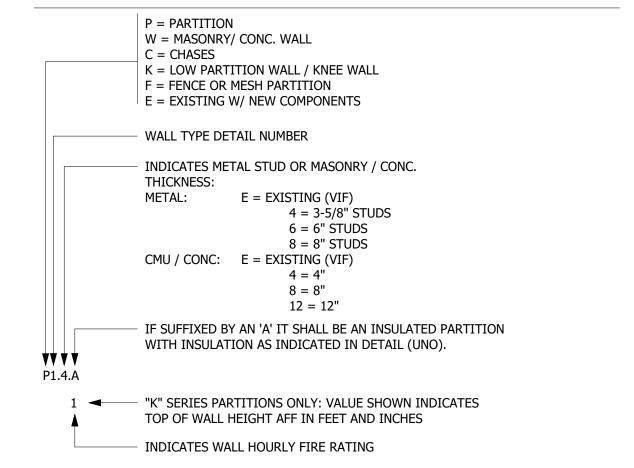

OWNER

CITY OF GREENACRES 5800 MELALEUCA LANE GREENACRES, FL, 33463

ARCHITECT

ROBE CONTROL ARCHITECTURE CONSTRUCTION AA26001115 EB28211 CGC1504260

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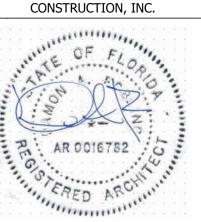
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DIGITAL SEAL

PROJECT NUMBER

585-2024-01 SHEET TITLE

MISCELLANEOUS DETAILS

					DO	oor sc	HEDU	LE		
	DOOR PANEL								AME	
	SIZE					Ð				
NUMBER	W	Н	TYPE	MATERIAL	KICKPLATE	FIRE RATING	HARDWARE	ТҮРЕ	MATERIAL	REMARKS
1-001	3' - 0"	7' - 0"	F	WD	_	-	01	01	WD	4
1-002	3' - 0"	7' - 0"	F	WD	-	-	01	01	WD	4
1-003	3' - 0"	7' - 0"	F	WD	-	-	01	01	WD	4
1-004	3' - 0"	7' - 0"	F	WD	-	-	01	01	WD	4
1-005	3' - 0"	7' - 0"	F	WD	-	-	01	01	WD	4
1-006	3' - 0"	7' - 0"	F	WD	-	-	01	01	WD	4
1-100	3' - 0"	7' - 0"	F	HM		~ ~ ~ ~ ~ ~ ~ ~ ~ ~ ~ ~ ~ ~ ~ ~ ~ ~ ~	02	02	НМ	1,3
EX01	3' - 0"	7' - 0"	EXIST	EXIST	EXIST	EXIST	EXIST	EXIST	EXIST	2

REMARKS

HEAD

SILL

- DOOR PANEL AND FRAME TO BE PAINTED ON INTERIOR SIDE.
- DOOR PANEL TO REMAIN AS IS. FRAME TO BE PAINTED ON SIDE OF AREA OF WORK. REUSE EXISTING HARDWARE. IF HARDWARE IS NOT COMPATIBLE WITH AUTOMATIC DOOR OPENER, REPLACE AS NEEDED FOR NEW AUTOMATIC DOOR OPENER TO FUNCTION.

SCHEDULED WALL

FRAME (TYP)

SCHEDULED WALL

CONTINUOUS FINISH FLOOR

DOUBLE STUD

CONT SEALANT BOTH SIDES OF

DOOR KIT TO BE HEAVY-DUTY & SOFT-CLOSE.

DOOR HARDWARE NOTES

- THE FOLLOWING SCHEDULE IS FURNISHED FOR WHATEVER ASSISTANCE IT MAY AFFORD THE CONTRACTOR; DO NOT CONSIDER IT AS ENTIRELY INCLUSIVE. SHOULD ANY PARTICULAR DOOR OR ITEM BE OMITTED IN ANY SCHEDULED HARDWARE GROUP, PROVIDE DOOR OR ITEM WITH HARDWARE SAME AS REQUIRED FOR SIMILAR PURPOSES. QUANTITIES LISTED ARE FOR EACH PAIR OF DOORS OR FOR EACH SINGLE
- THE INTENT OF THE HARDWARE SPECIFICATION IS TO SPECIFY THE HARDWARE FOR INTERIOR AND EXTERIOR DOORS, AND TO ESTABLISH A TYPE, CONTINUITY, AND STANDARD OF QUALITY. HOWEVER, IT IS THE DOOR HARDWARE SUPPLIER'S RESPONSIBILITY TO THOROUGHLY REVIEW EXISTING CONDITIONS, SCHEDULES, SPECIFICATIONS, DRAWINGS, AND OTHER CONTRACT DOCUMENTS TO VERIFY THE SUITABILITY OF THE HARDWARE SPECIFIED.

DOOR HARDWARE GROUPS

CONTRACTOR SHALL FURNISH AND INSTALL THE DOOR TO DELIVER A FULLY FUNCTIONAL PRODUCT WITH ALL THE HARDWARE, POWER SUPPLY, WIRING AND WARRANTY REQUIRED BY OWNER.

HARDWARE GROUP NO. 01 - POCKET DOOR PROVIDE EACH DOOR(S) WITH THE FOLLOWING: DESCRIPTION

1 EA PRIVACY POCKET DOOR LOCK SLIDING DOOR TRACK AND ROLLERS 1 EA

HARDWARE GROUP NO. 02 - EXTERIOR DOOR W/ PANIC DEVICE & AUTOMATIC OPENER PROVIDE SCHEDULED DOOR WITH THE FOLLOWING:

CECO HOLLOW METAL FRAME LEVEL E CECO FLUSH HOLLOW METALL DOOR LEGION SERIES

DESCRIPTION (HAGER BB1199 4 1/2" X 4 1/2" X US32D NRP 3 EA. HINGES 1 EA. EXIT DEVICE SARGENT 56-HC4 8706 ETL US32D (SURFACE VERTICAL ROD EXIT DEVICE WITH ELECTRIC LATCH RETRACTION)

1 EA. CYLINDER FOR ABOVE (CONFIRM KEYWAY/KEYING REQUIREMENTS) 1 EA. POWER TRANSFER SECURITRON EL-CEPT 1 EA. **AUTO OPERATOR** BY OTHERS. (SW200I)

1 EA. **PUSH BUTTON** BY OTHERS 1 EA. CABLE MCKINNEY QC-C012P QC-C1500P 1 EA. CABLE MCKINNEY

FRAMES IN WALLS WIDER THAN 8" SHALL BE CENTERED SO THAT

8" FROM FINISHED FACE OF WALL

EXIST CMU / CONC

EXIST BEAM / LINTEL

PAINTED FINISH, PLASTER

OR FURRING, INSUL &

PT SHIM AS REQUIRED

SCHEDULED DOOR

EXIST CMU / CONC

PAINTED FINISH, PLASTER

OR FURRING, INSUL & GWB (MATCH EXIST)

PT SHIM AS REQUIRED

SCHEDULED DOOR

SCHEDULED DOOR

FILL DIMPLE W/ BONDO & SAND

SILL

SMOOTH TO MATCH FRAME

HEAD

GWB (MATCH EXIST)

TREMCO DYMONIC 100 OR APPROVED EQUAL (TYP)

EITHER FACE OF THE DOOR SHALL NOT BE RECESSED GREATER THAN

DOOR OPENING HEAD AND JAMBS TO HAVE LIQUID FLASHING (4" RETURN)

1 EA. KICKPLATE ROCKWOOD K1050 10 X 34 X BCS X US32D. 1 EA. THRESHOLD NGP 896V X 36" 1 EA.

EXIST PAINTED STUCCO

PAINTED STUCCO (NEW OR

PATCH & REPAIR AS REO'D

TO MATCH EXISTING)

CONT BACKER ROD &

APPLIED RAIN DRIP

5-3/4" (UNO) HOLLOW

METAL FRAME FILLED SOLID W/ GROUT

EXIST PAINTED STUCCO

PAINTED STUCCO (NEW OR

PATCH & REPAIR AS REQ'D

CONT SEALANT & BACKER

ROD BOTH SIDES OF

5-3/4" (UNO) HOLLOW

METAL FRAME FILLED SOLID W/ GROUT

EXTERIOR

ADA COMPLIANT THRESHOLD IN A

SEALANT

SLOPE

CONTINUOUS BED OF

TO MATCH EXISTING) ANCHORS PER DOOR MANF

SEALANT BOTH SIDES OF

WEATHERSTRIP 160V 36" X 84"

GENERAL NOTES

- CONTRACTOR SHALL FIELD VERIFY AND COORDINATE ALL FRAMES, DOOR SIZES & HARDWARE WITH OPENINGS PRIOR TO PURCHASE AND INSTALLATION.
- ITEMS IN REMARKS EITHER REPLACE, REMOVE, OR ADD TO ITEMS LISTED IN HARDWARE SETS.
 - COORDINATE DOOR FRAME DIMENSIONS WITH DOORS.
- DOOR FRAMES IN CMU WALLS SHALL BE 5-3/4" WIDE (UNO).
- REFER TO FLOOR PLANS FOR WALL TYPE LOCATIONS AND WALL TYPE SHEETS FOR DOOR SUPPLIER TO COORDINATE THE REQUIRED THROAT OPENINGS FOR WRAP AROUND HM DOOR FRAMES IN GWB PARTITIONS.
- ALL FIRE RATED DOORS SHALL BE SELF-CLOSING AND LATCHING.
- ALL HARDWARE ASSOCIATED WITH FIRE RATED DOOR ASSEMBLIES SHALL BE U.L. LISTED FIRE RATED HARDWARE.
- PROVIDE FIRE RATED FRAMES WITH FIRE RATED DOORS.
- ALL THRESHOLDS AND TRANSITIONS SHALL BE ADA COMPLIANT.
- ALL PRODUCTS ARE TO BE INSTALLED PER NOA / FL PRODUCT APPROVAL AND MANUFACTURER'S INSTRUCTIONS AS APPLICABLE.
- REFER TO SHEET A1.1 FOR FINISH SCHEDULE.


NOA/FLORIDA PRODUCT APPROVAL

ALL HARDWARE INSTALLED IN EXTERIOR DOORS REQUIRES NOA OR FLORIDA PRODUCT APPROVAL. IF HARDWARE CANNOT MEET NOA OR FLORIDA PRODUCT APPROVAL INDEPENDENTLY OF DOOR, REPLACE ENTIRE DOOR.


FORCES TO UNLATCH & OPEN DOORS

- THE FORCES TO UNLATCH DOORS SHALL COMPLY WITH THE FOLLOWING: WHERE DOOR HARDWARE OPERATES BY PUSH OR PULL, THE OPERATIONAL FORCE TO UNLATCH THE DOOR SHALL NOT EXCEED 15 POUNDS (66.7N).
- WHERE DOOR HARDWARE OPERATES BY ROTATION, THE OPERATIONAL FORCE TO UNLATCH THE DOOR SHALL NOT EXCEED 28 INCH-POUNDS (315 N-CM)
- THE FORCES TO OPEN DOORS SHALL COMPLY WITH THE FOLLOWING: FOR INTERIOR SWINGING EGRESS DOORS THAT ARE MANUALLY OPERATED, OTHER THAN DOORS REQUIRED TO BE FIRE RATED, THE FORCE FOR PUSHING OR PULLING OPEN THE DOOR SHALL NOT EXCEED 5 POUNDS (22 N).
- FOR OTHER SWINGING DOORS, SLIDING DOORS OR FOLDING DOORS, AND DOORS REQUIRED TO BE FIRE RATED, THE DOOR SHALL REQUIRE NOT MORE THAN A 30-POUND (133 N) FORCE TO BE SET IN MOTION AND SHALL MOVE TO A FULL OPEN POSITION WHEN SUBJECTED TO NOT MORE THAN A 15- POUND (67 N) FORCE.

LEGEND

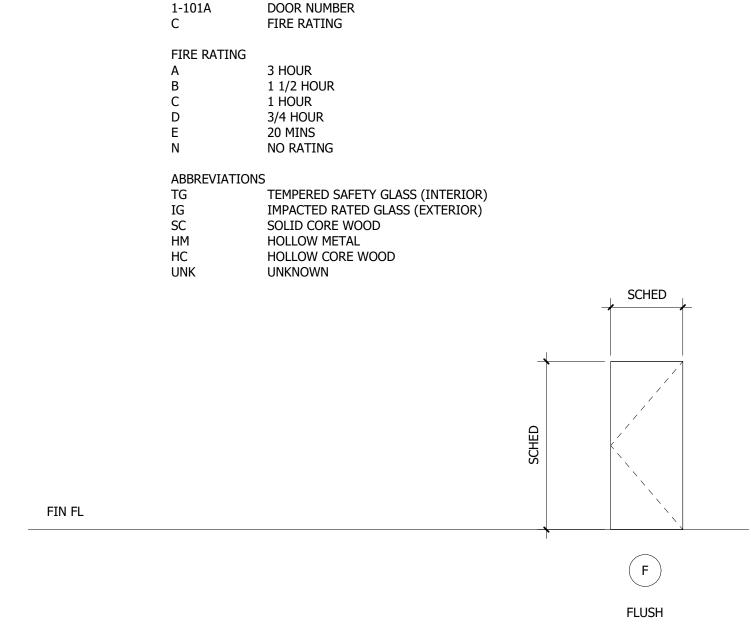

DOOR PANEL ELEVATIONS TYPES

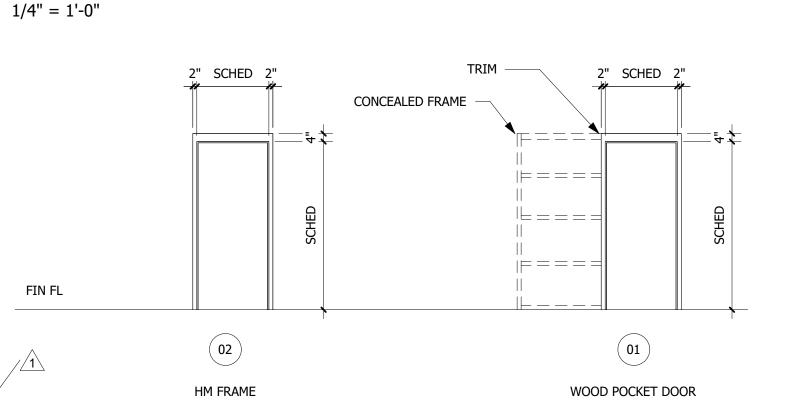

POCKET DOOR IN PARTITION

NEW DOOR IN EXISTING CMU OPENING DOOR FRAME ELEVATIONS TYPES 1 1/2" = 1'-0"

1/4" = 1'-0"

OWNER

CITY OF GREENACRES

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PROJECT TITLE

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GREENACRES, FL 33463

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SUBMITTAL HISTORY No. DATE DESCRIPTION

10/29/25 OWNER REVISIONS

THE DRAWINGS AND SPECIFICATIONS INCLUDED OR REFERENCED HEREIN SHALL BE USED AS A COMPLETE SET AND SHALL NOT BE SEPARATED INTO INDIVIDUAL SHEETS OR BY

DISCIPLINE. INFORMATION CONTAINED ON ONE SHEET MAY SPECIFICALLY APPLY TO INFORMATION OR CONDITIONS ILLUSTRATED ON OTHER SHEETS.

HAT SUCH ITEMS ARE COORDINATED AND INCLUDED IN ANY PRICING INFORMATION. FIELD VERIFY AND NOTIFY THE ARCHITECT OF ANY DEVIATIONS FROM THE PLANS AND / OR SPECS

PRIOR TO CONSTRUCTION

© ROBLING ARCHITECTURE



DIGITAL SEAL

PROJECT NUMBER 585-2024-01

SHEET TITLE

DOOR AND WINDOW **SCHEDULE & ELEVATIONS**